## PROSED RESIDENTIAL DEVELOPMENT LOT 211 LORD SHEFFIELD CIRCUIT, PENRITH STORMWATER CONCEPT DESIGN



DRAWINGS LIST				
SHEET No.	DWG No.	TITLE	REV	
1	SW100	COVER SHEET	А	
2	SW200	STORMWATER CONCEPT DESIGN - BASEMENT PLAN	A	
3	SW201	STORMWATER CONCEPT DESIGN - GROUND FLOOR PLAN - SHEET 1 OF 2	A	
4	SW202	STORMWATER CONCEPT DESIGN - GROUND FLOOR PLAN - SHEET 2 OF 2	A	
5	SW300	STORMWATER CONCEPT DESIGN - DETAILS SHEET	A	
6	SW400	EROSION AND SEDIMENT CONTROL - PLAN AND DETAILS	A	

NOT TO SCALE
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## PREPARED BY:


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**ARCHITECT:** 





CLIENT:



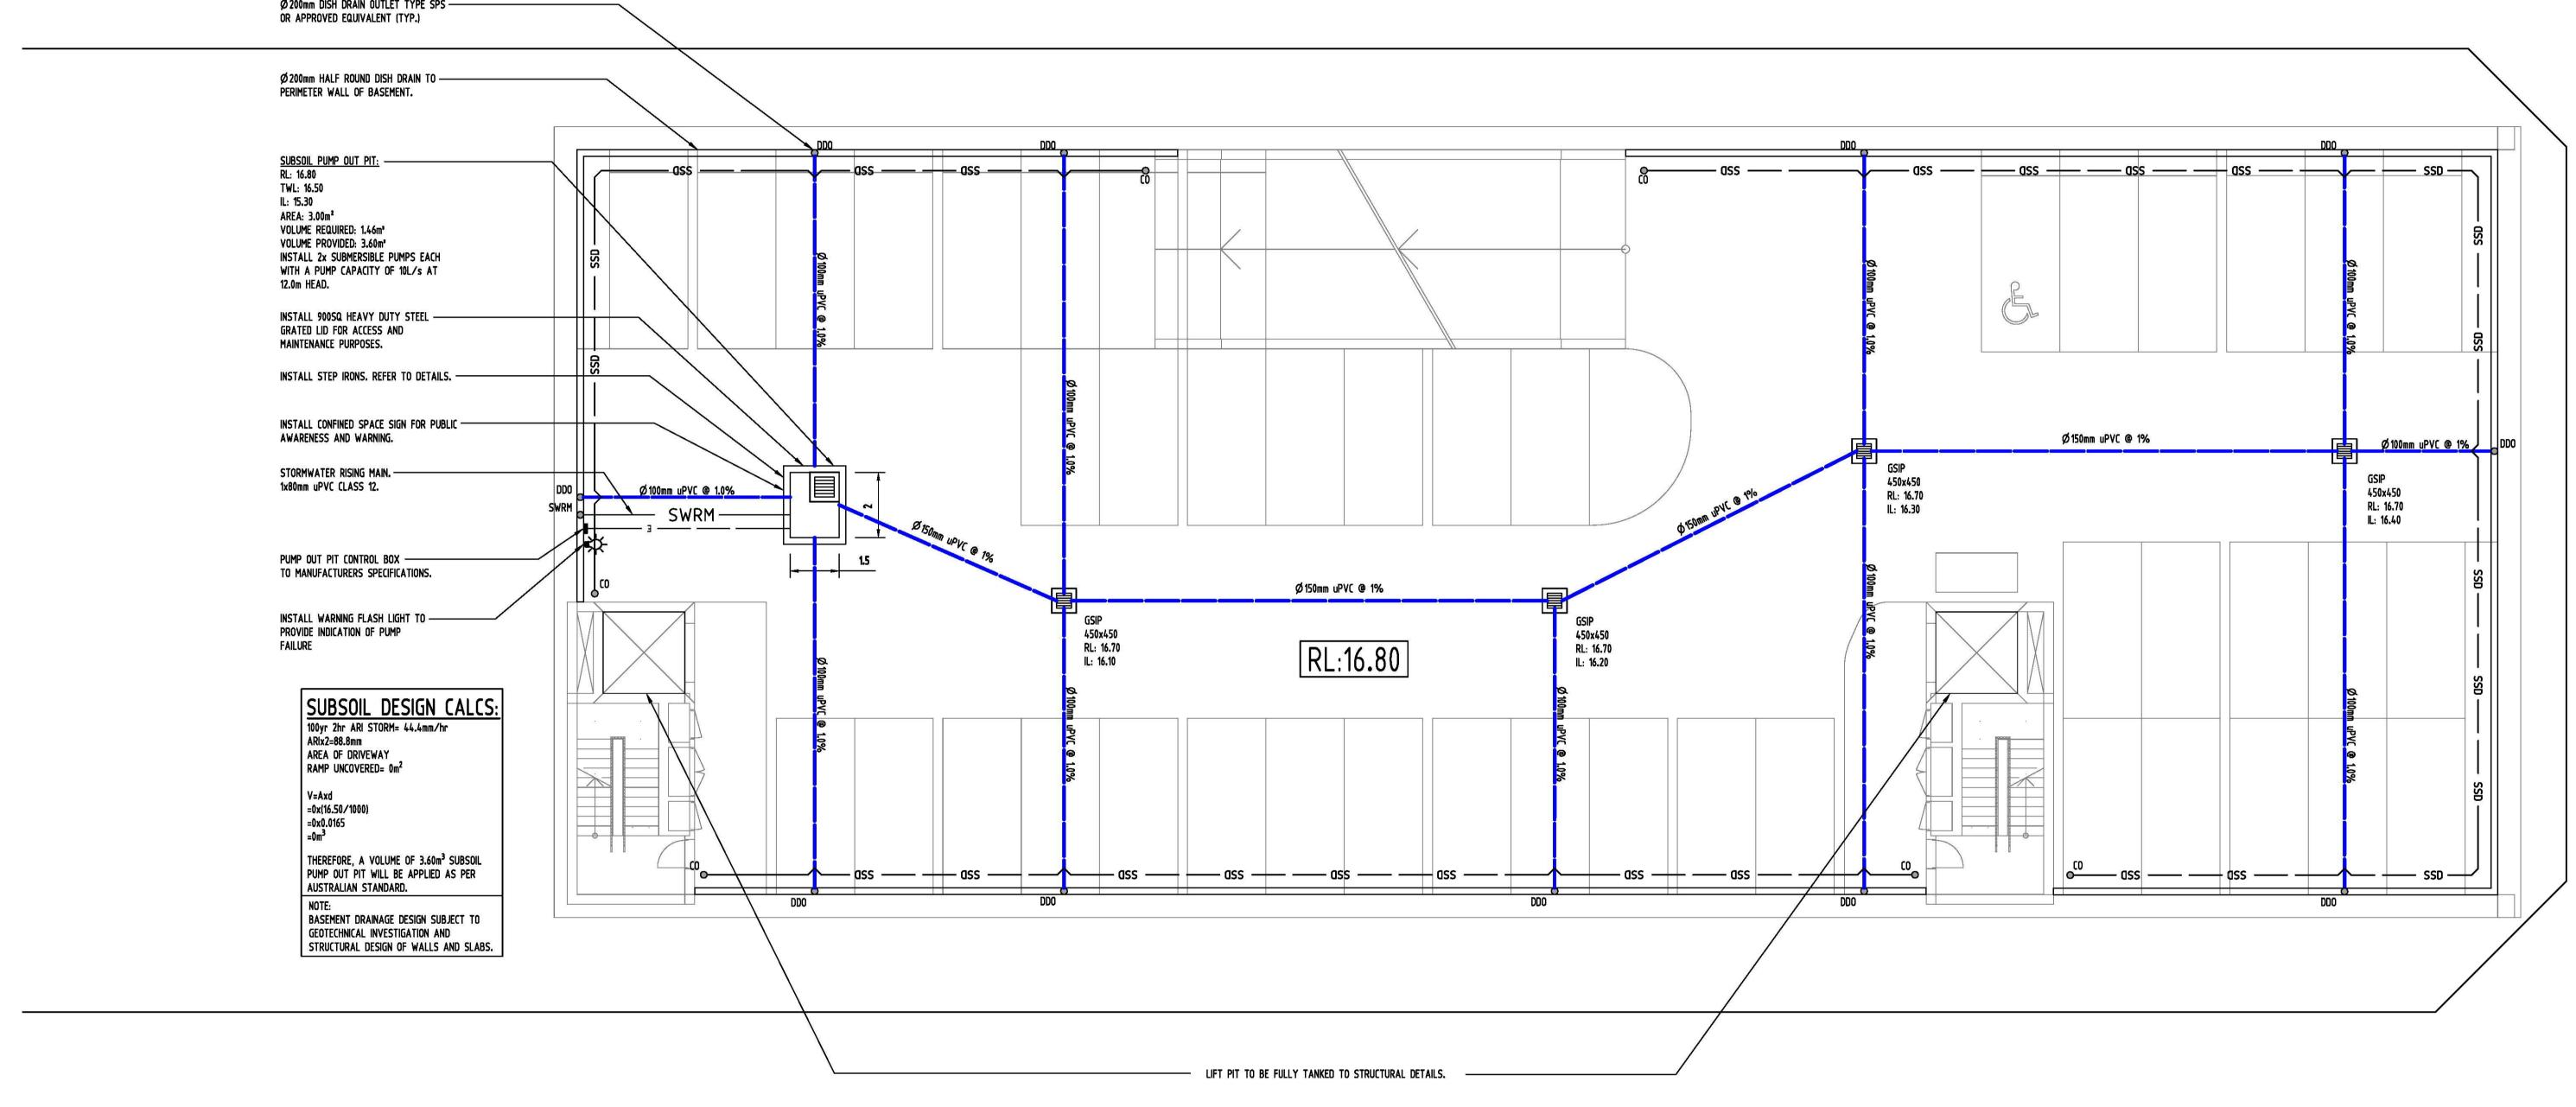

					Reference Coordination Drawing			ENGINEERS	QUALITY CONTROL				
					Discipline	Drawing Title and Number	Date	Rev.	AUSTRALIA Chartered Professional Engineer MEMBER	DRAWN	AA	DATE	04.04.19
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A	ISSUE FOR DA	AA	04.04.19	2	ELEC HYD				PRIOR TO COMMENCEMENT OF WORK, REPORT ANY DISCREPANCIES TO THE CONSULTING				
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Issuer internal sequence and revision history 1-preliminary 2-development application 3-construction certificate 4-tender 5-construction 6-other			ate	LANDS				DRAWING IS TO BE DEAD IN COMMINICTION	APPROVED	SH	DATE	04.04.19	
			SURVEY				CONSULTANTS' DRAWINGS.		3.2.1.08	3/1/2			

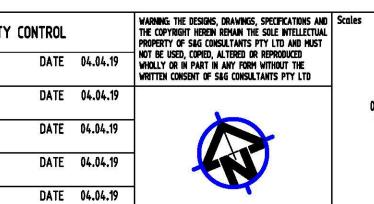

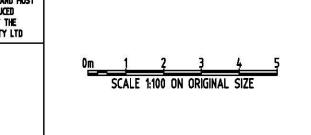

CLIENT

**URBAN** 





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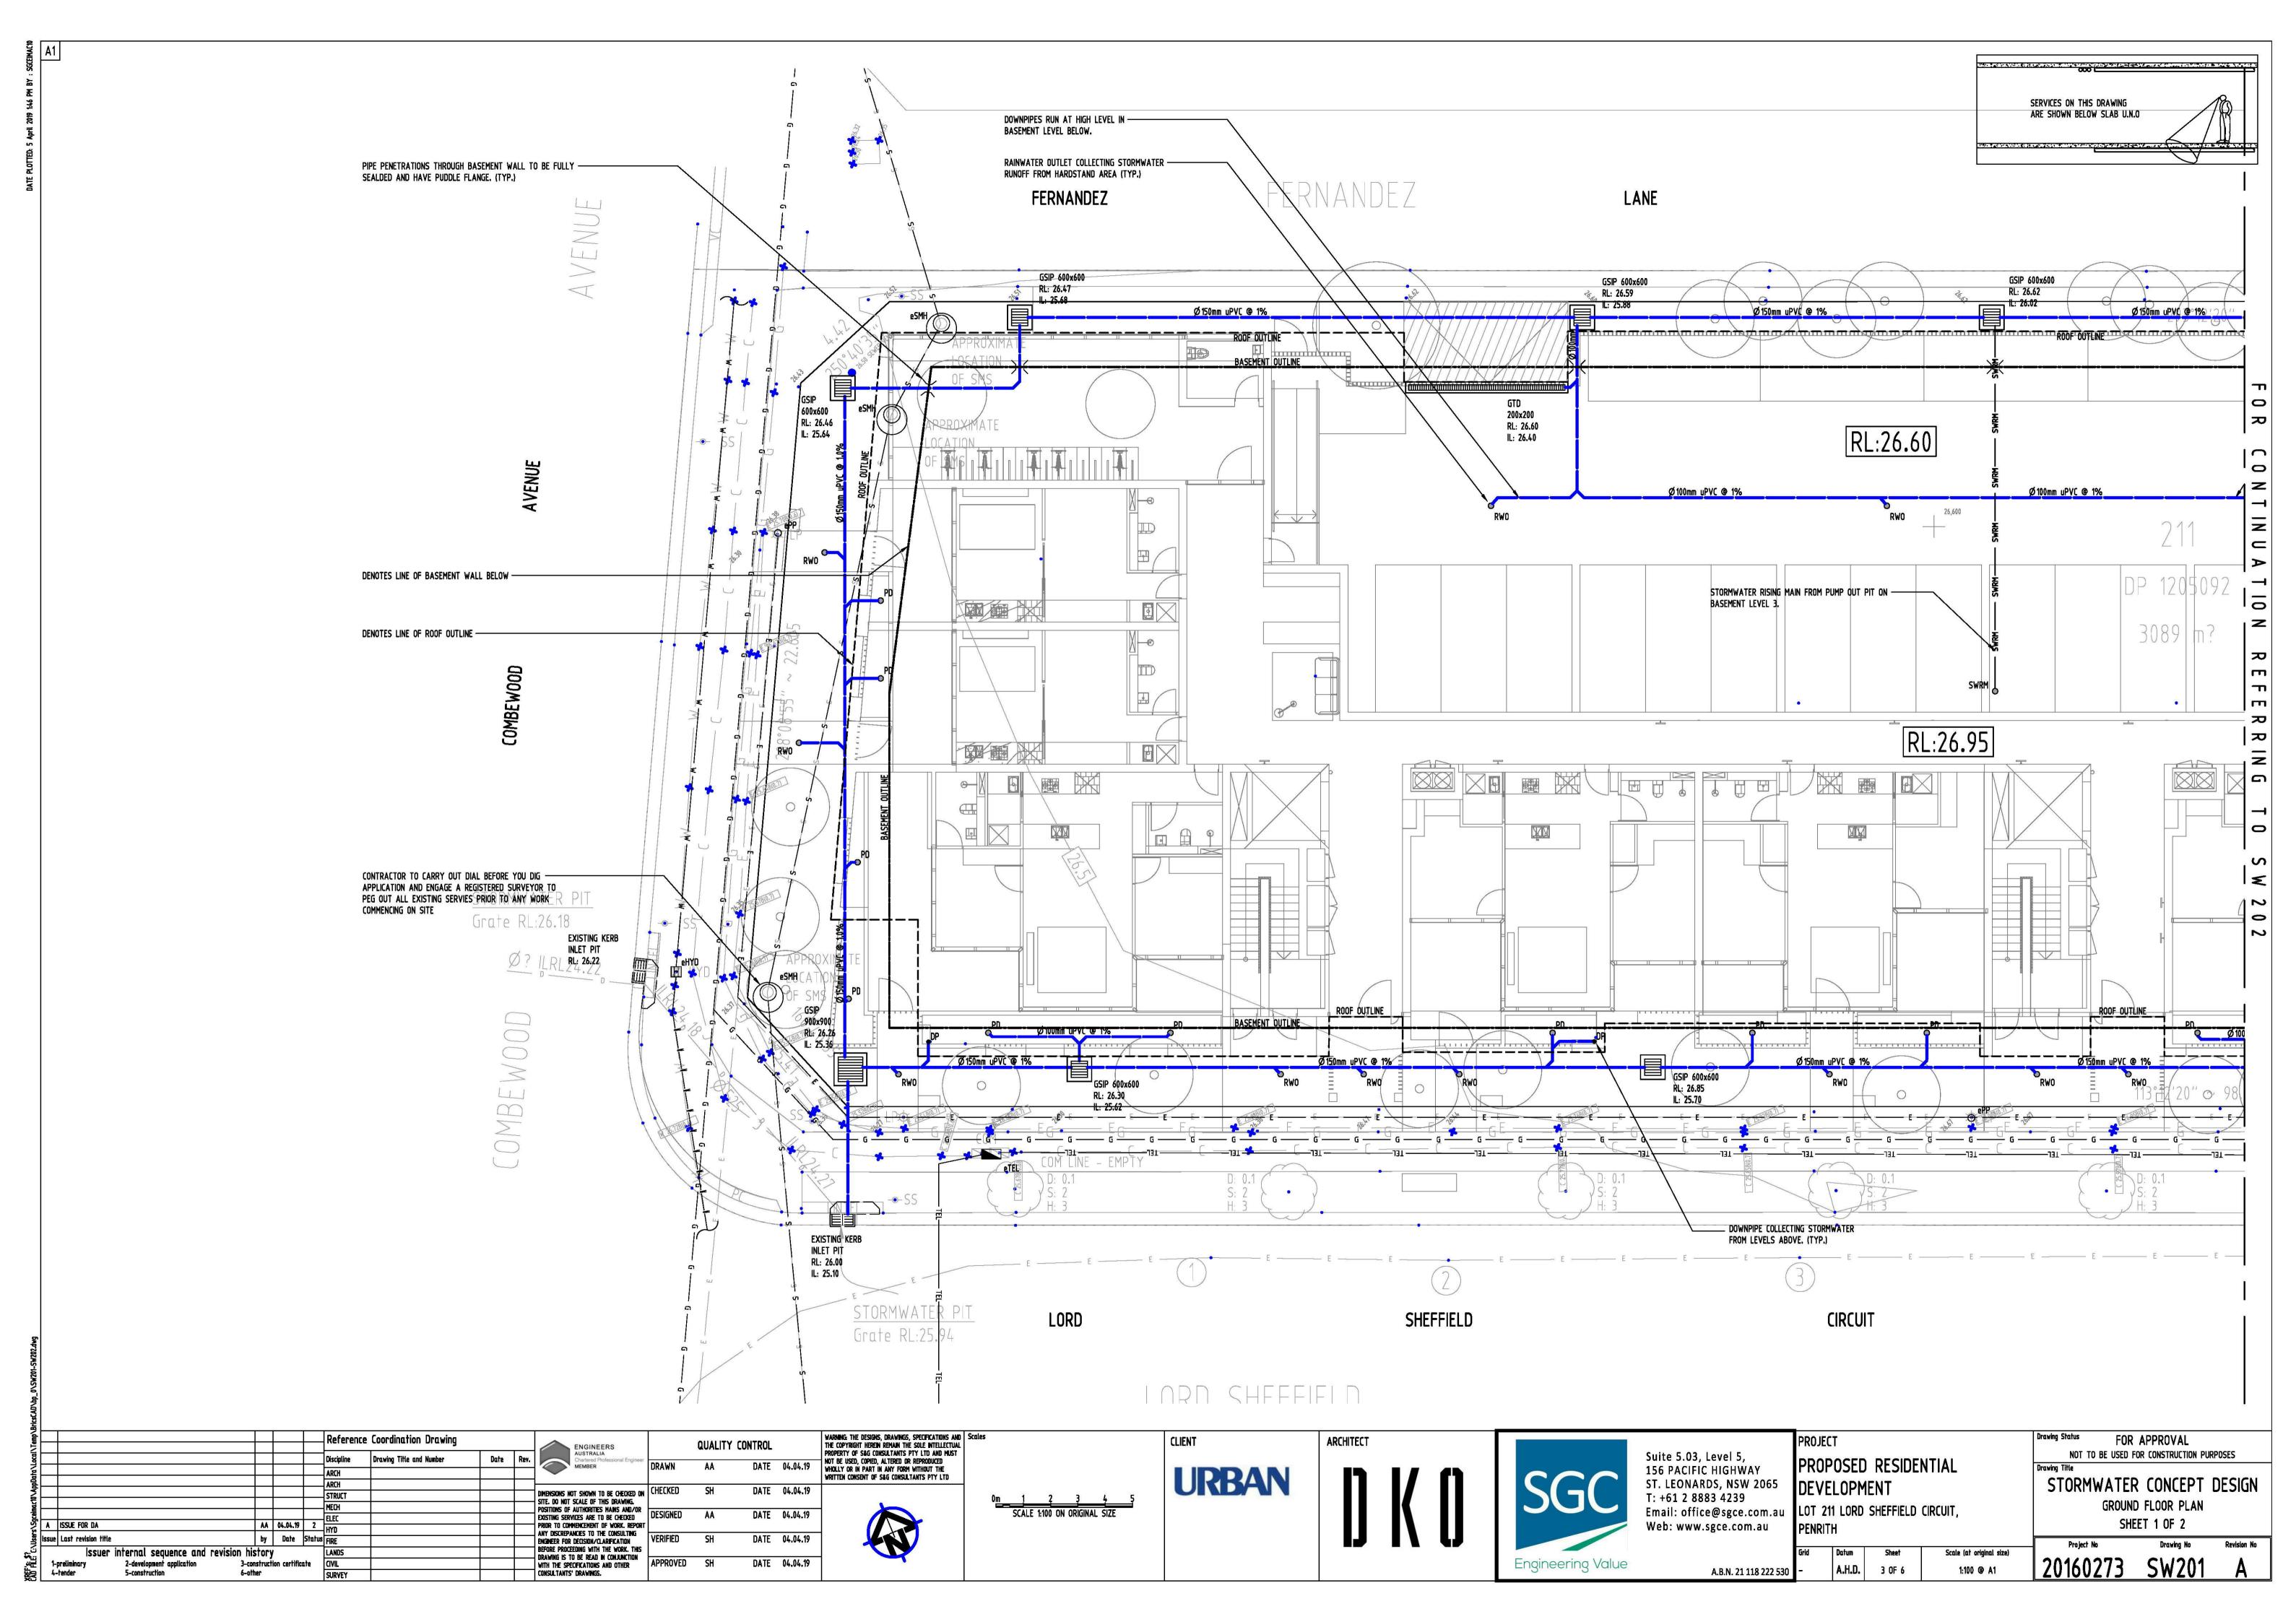
DEVELOPMENT
LOT 211 LORD SHEFFIELD CIRCUIT,


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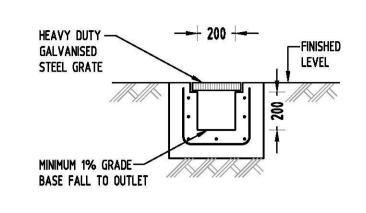
1:100 @ A1


FOR APPROVAL NOT TO BE USED FOR CONSTRUCTION PURPOSES STORMWATER CONCEPT DESIGN BASEMENT PAAN

Scale (at original size)







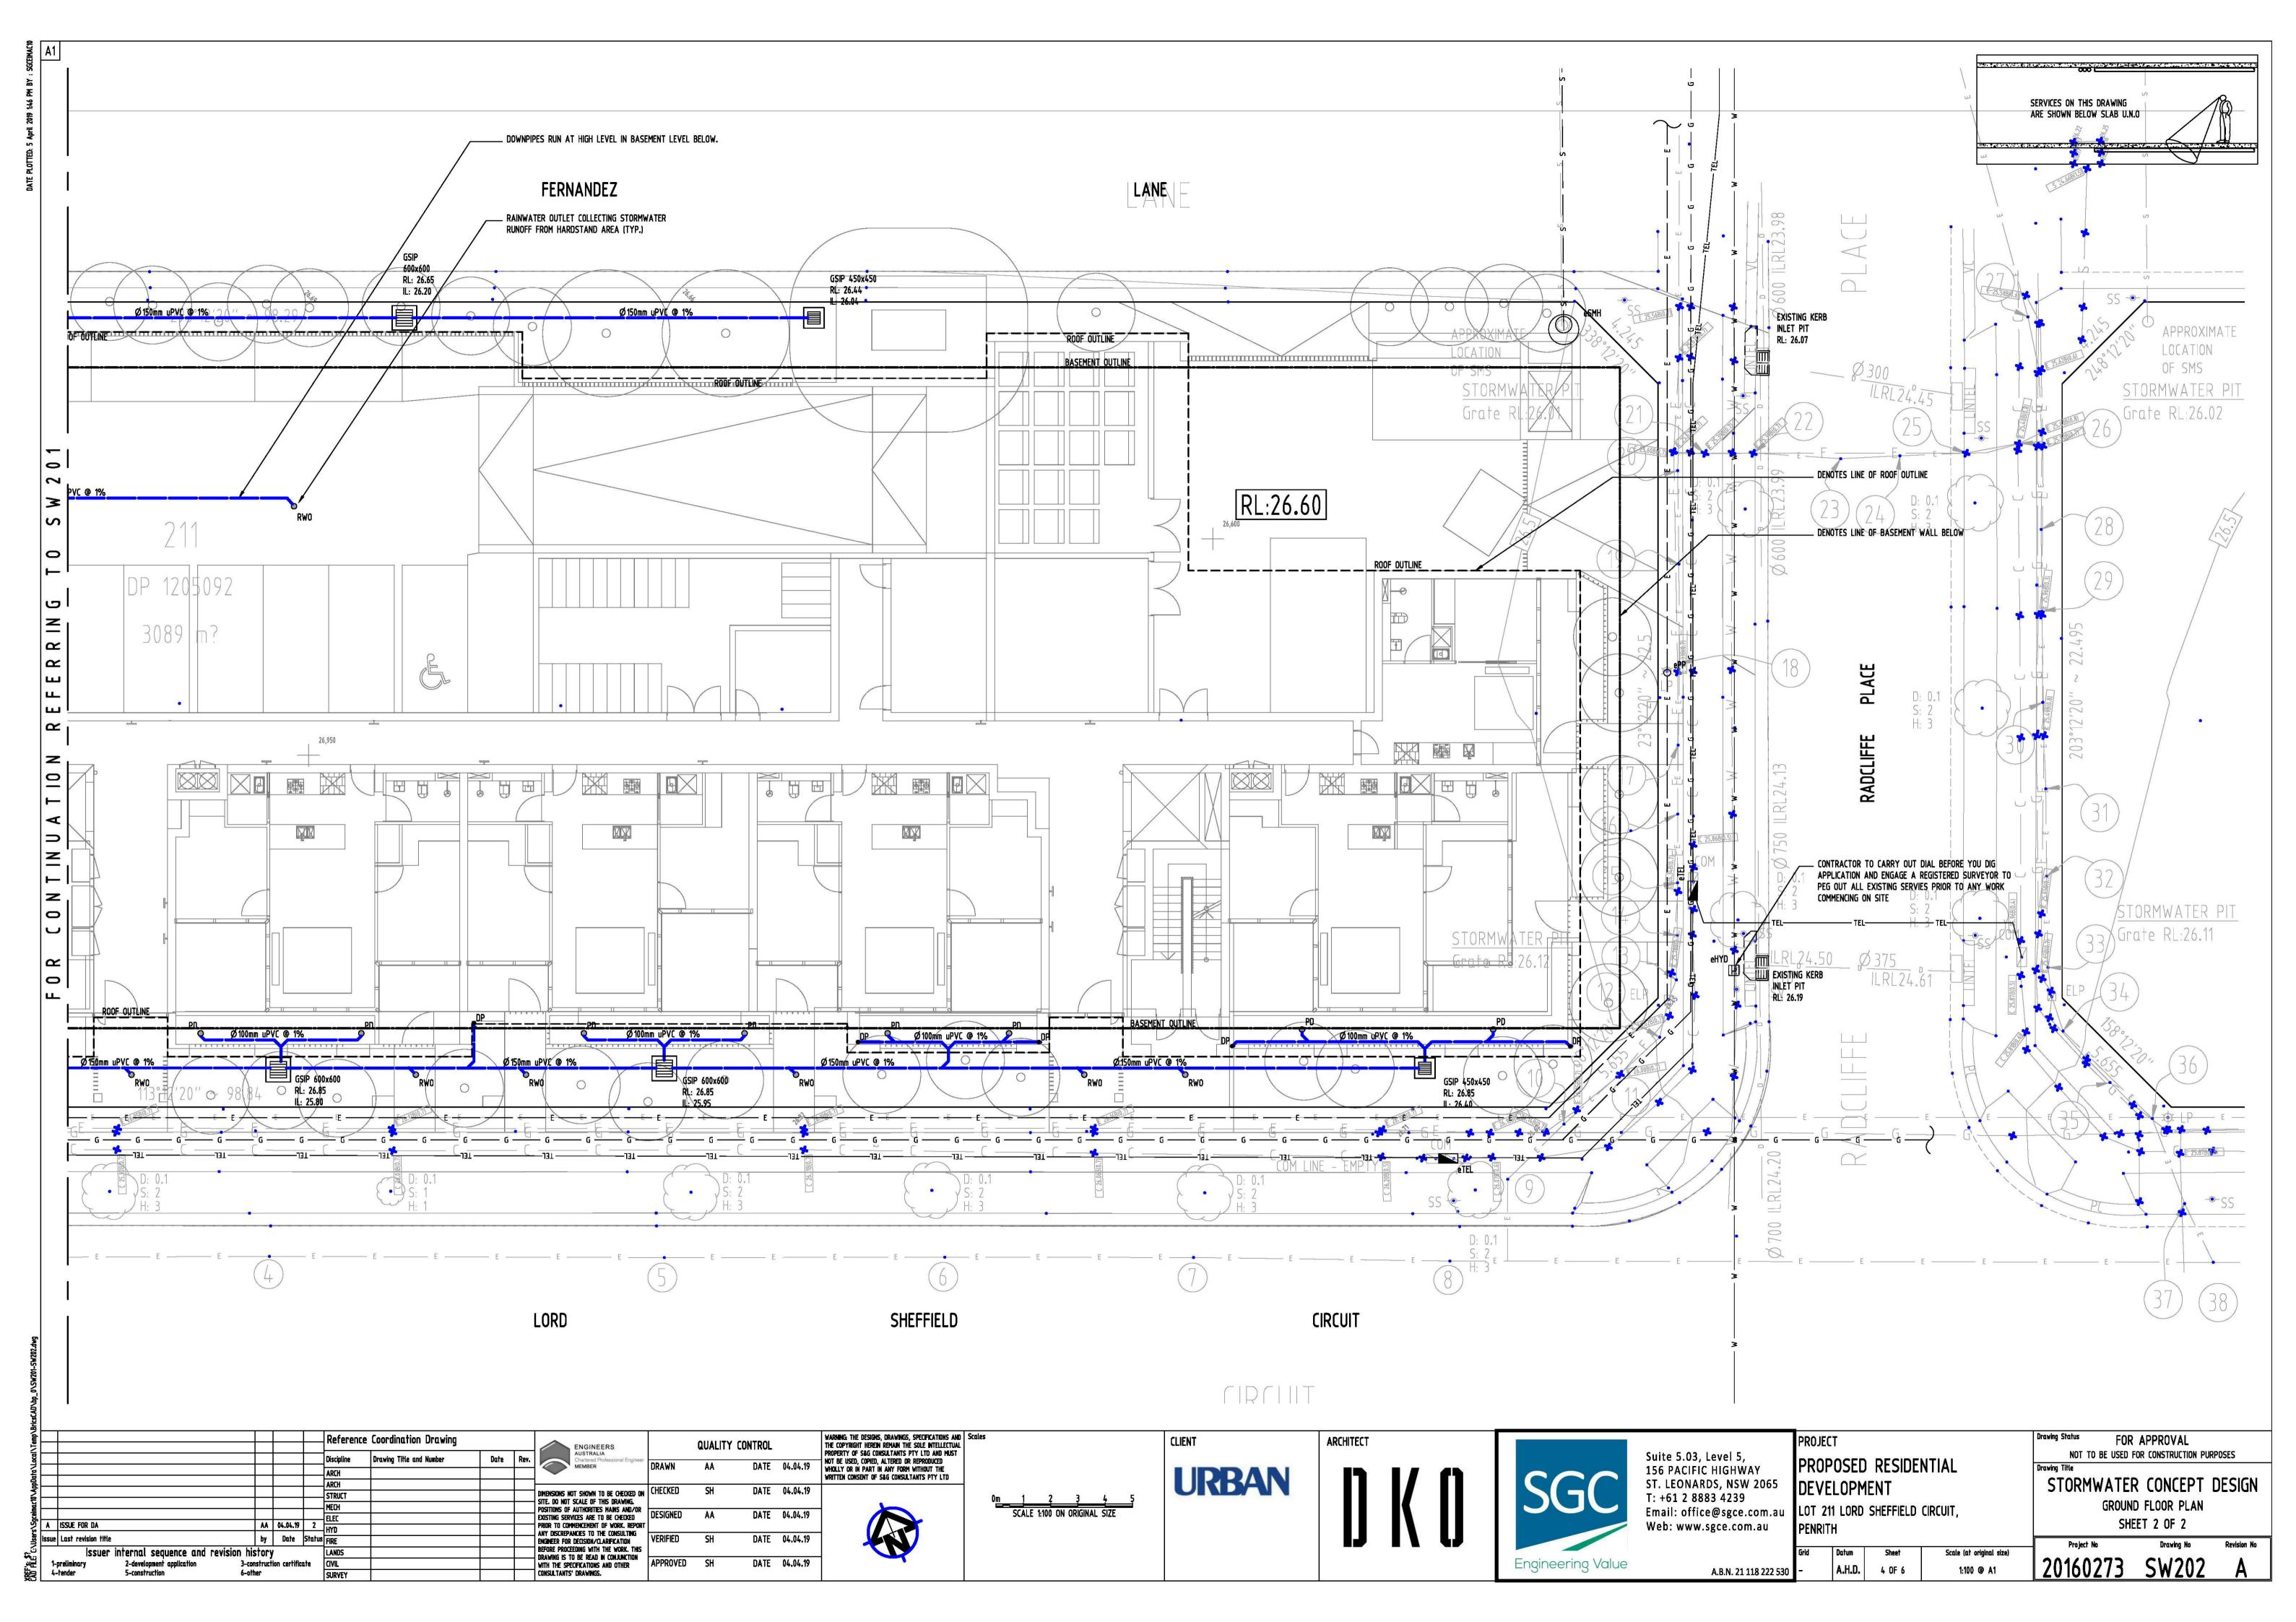

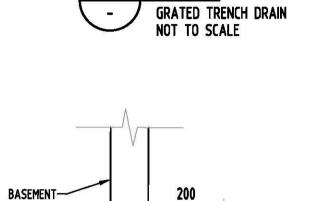



DETAIL

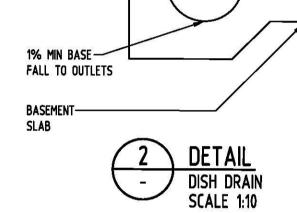


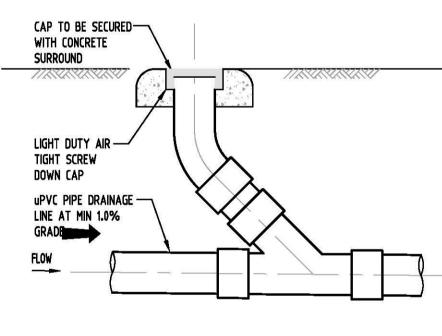



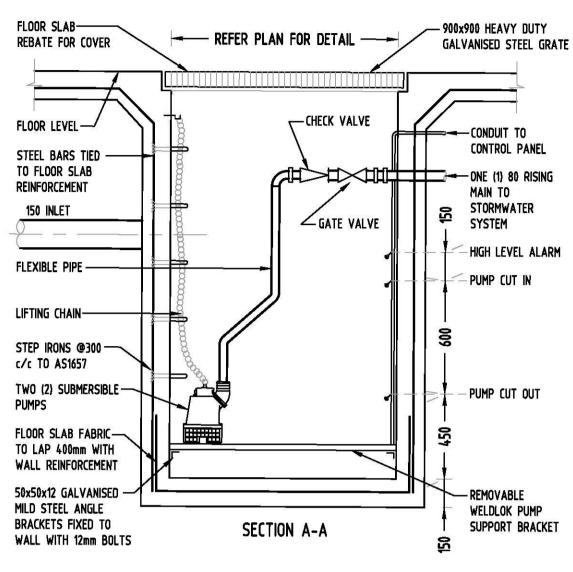


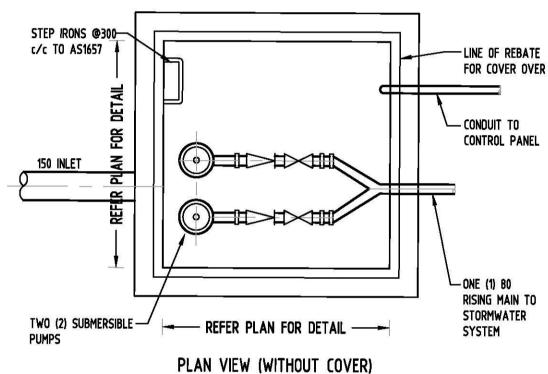

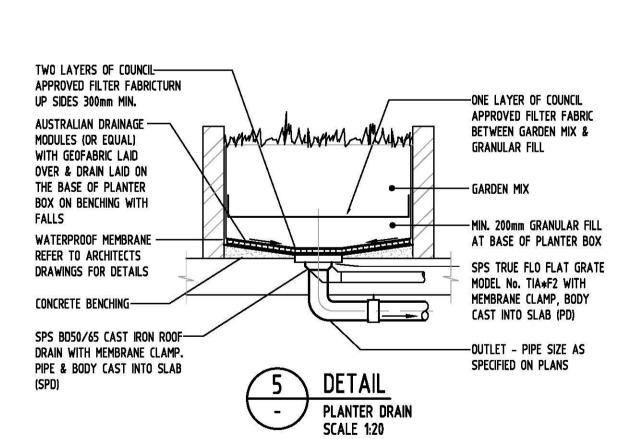

DETAIL

SUBSOIL PUMP OUT PIT SCALE 1:20

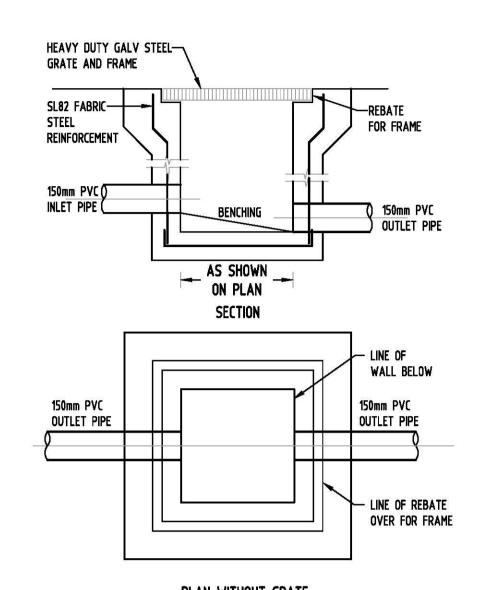

PLAN WITHOUT GRATE

STORMWATER PIT

## DRAINAGE NOTES:

ALL PIPES TO BE LAID ON 75mm SAND BED WITH THE BARRELS FULLY SUPPORTED

100mm AND 150mm DIAMETER PIPES TO BE LAID ON MINIMUM 1% GRADE

MINIMUM DEPTH OF COVER FOR PIPES NOT SUBJECT TO VEHICULAR LOADING TO BE 300mm

ALL DRAINAGE PIPES LAID UNDER PAVEMENT SHALL BE REINFORCED CONCRETE WITH RUBBER RING

BACKFILL TRENCHES WITH COMPACTED SAND OR APPROVED AGGREGATE MATERIAL

HEAVY DUTY GRATES AND COVERS ARE TO BE PROVIDED IN TRAFFICABLE AREAS

PIT GRATE TO BE TYPE WELDLOK OR APPROVED EQUIVALENT

ALL PITS SHALL BE PROVIDED WITH A LOCKING CLIP

ALL PITS SHALL BE MAINTAINED REGULARLY

TOP OF BENCHING SHALL BE TO THE HALF OF THE OUTLET PIPE DIAMETER

Ø100 SUBSOIL DRAINAGE PIPE 3000mm LONG WRAPPED IN FABRIC SOCK TO BE PROVIDED ADJACENT TO INLET PIPES

COMPRESSIVE STRENGTH f'E FOR CAST IN SITU CONCRETE TO BE A MINIMUM OF 20MPa AT 28

ISOLATED JOINTS TO BE PROVIDED TO ISOLATE CONCRETE PAVEMENTS FROM PITS

ALL TRENCH GRATES PROVIDED SHALL HAVE A MINIMUM CLEAR WIDTH OF 200mm

STORMWATER DRAINAGE CONNECTIONS TO THE MAIN SYSTEM SHALL BE TO THE REQUIREMENTS AND THE SATISFACTION OF LOCAL COUNCIL

## **DESIGN NOTES:**

THE SITE IS LOCATED IN PENRITH CITY COUNCIL LGA.

SITE AREA: 3084.00m2

ON-SITE DETENTION IS NOT REQUIRED ACCORDING TO COUNCIL STORMWATER ENGINEER.

WSUD IS NOT REQUIRED ACCORDING TO COUNCIL STORMWATER ENGINEER.

SERVICES SHOWN ON PLAN ARE INDICATIVE, EXACT DEPTH AND LOCATION TO BE CONFIRMED ONSITE. CONTRACTOR TO CARRY OUT DIAL BEFORE YOU DIG APPLICATION AND ENGAGE A REGISTERED SURVEYOR TO PEG OUT ALL EXISTING SERVICES PRIOR TO ANY WORK COMMENCING ONSITE.

LEGEND:	
	STORMWATER LINE
———— SSD ———	SUBSOIL LINE
	STORMWATER RISING MAIN
е	EXISTING STORMWATER LINE
SW SW	AUTHORITY STORMWATER LINE
s	AUTHORITY SEWER LINE
w	AUTHORITY WATER LINE
—— с —— с ——	AUTHORITY GAS LINE
— — Е —	AUTHORITY ELECTRICITY LINE
—— UE— ——	AUTHORITY UNDERGROUND ELECTRICITY LINE
	AUTHORITY FIBRE OPTIC LINE
TEL-	AUTHORITY COMMS LINE
//////	FENCE LINE

GRATED SURFACE INLET PIT WITH ENVIROPOD INSERT

GRATED SURFACE INLET PIT

JUNCTION PIT



KERB INLET PIT



EXISTING KERB INLET PIT

OVERLAND FLOW PATH

RAINWATER OUTLET

DISH DRAIN OUTLET

PLANTER DRAIN

DOWNPIPE

WALL PENETRATION

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Bric			
Temp			
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Reference Coordination Drawing QUALITY CONTROL Drawing Title and Number Date Rev. DIMENSIONS NOT SHOWN TO BE CHECKED ON CHECKED SH

SITE, DO NOT SCALE OF THIS DRAWING,
POSITIONS OF AUTOMOTIVE MARKET AND CO. POSITIONS OF AUTHORITIES MAINS AND/OR EXISTING SERVICES ARE TO BE CHECKED DESIGNED PRIOR TO COMMENCEMENT OF WORK, REPORT ANY DISCREPANCIES TO THE CONSULTING by Date Status FIRE ENGINEER FOR DECISION/CLARIFICATION
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SCALE 1:100 ON ORIGINAL SIZE

**URBAN** 





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**PROJECT** DEVELOPMENT Email: office@sgce.com.au LOT 211 LORD SHEFFIELD CIRCUIT,

PROPOSED RESIDENTIAL

5 OF 6

A.H.D.

Scale (at original size)

AS SHOWN

NOT TO BE USED FOR CONSTRUCTION PURPOSES STORMWATER CONCEPT DESIGN **DETAILS SHEET** 

FOR APPROVAL

